



Transport
for NSW


BLACKTOWN CITY COUNCIL

RICHMOND ROAD WIDENING

CONCEPT DESIGN

RICHMOND RD BETWEEN WESTLINK M7 AND TOWNSON RD

100% CONCEPT DESIGN SUBMISSION

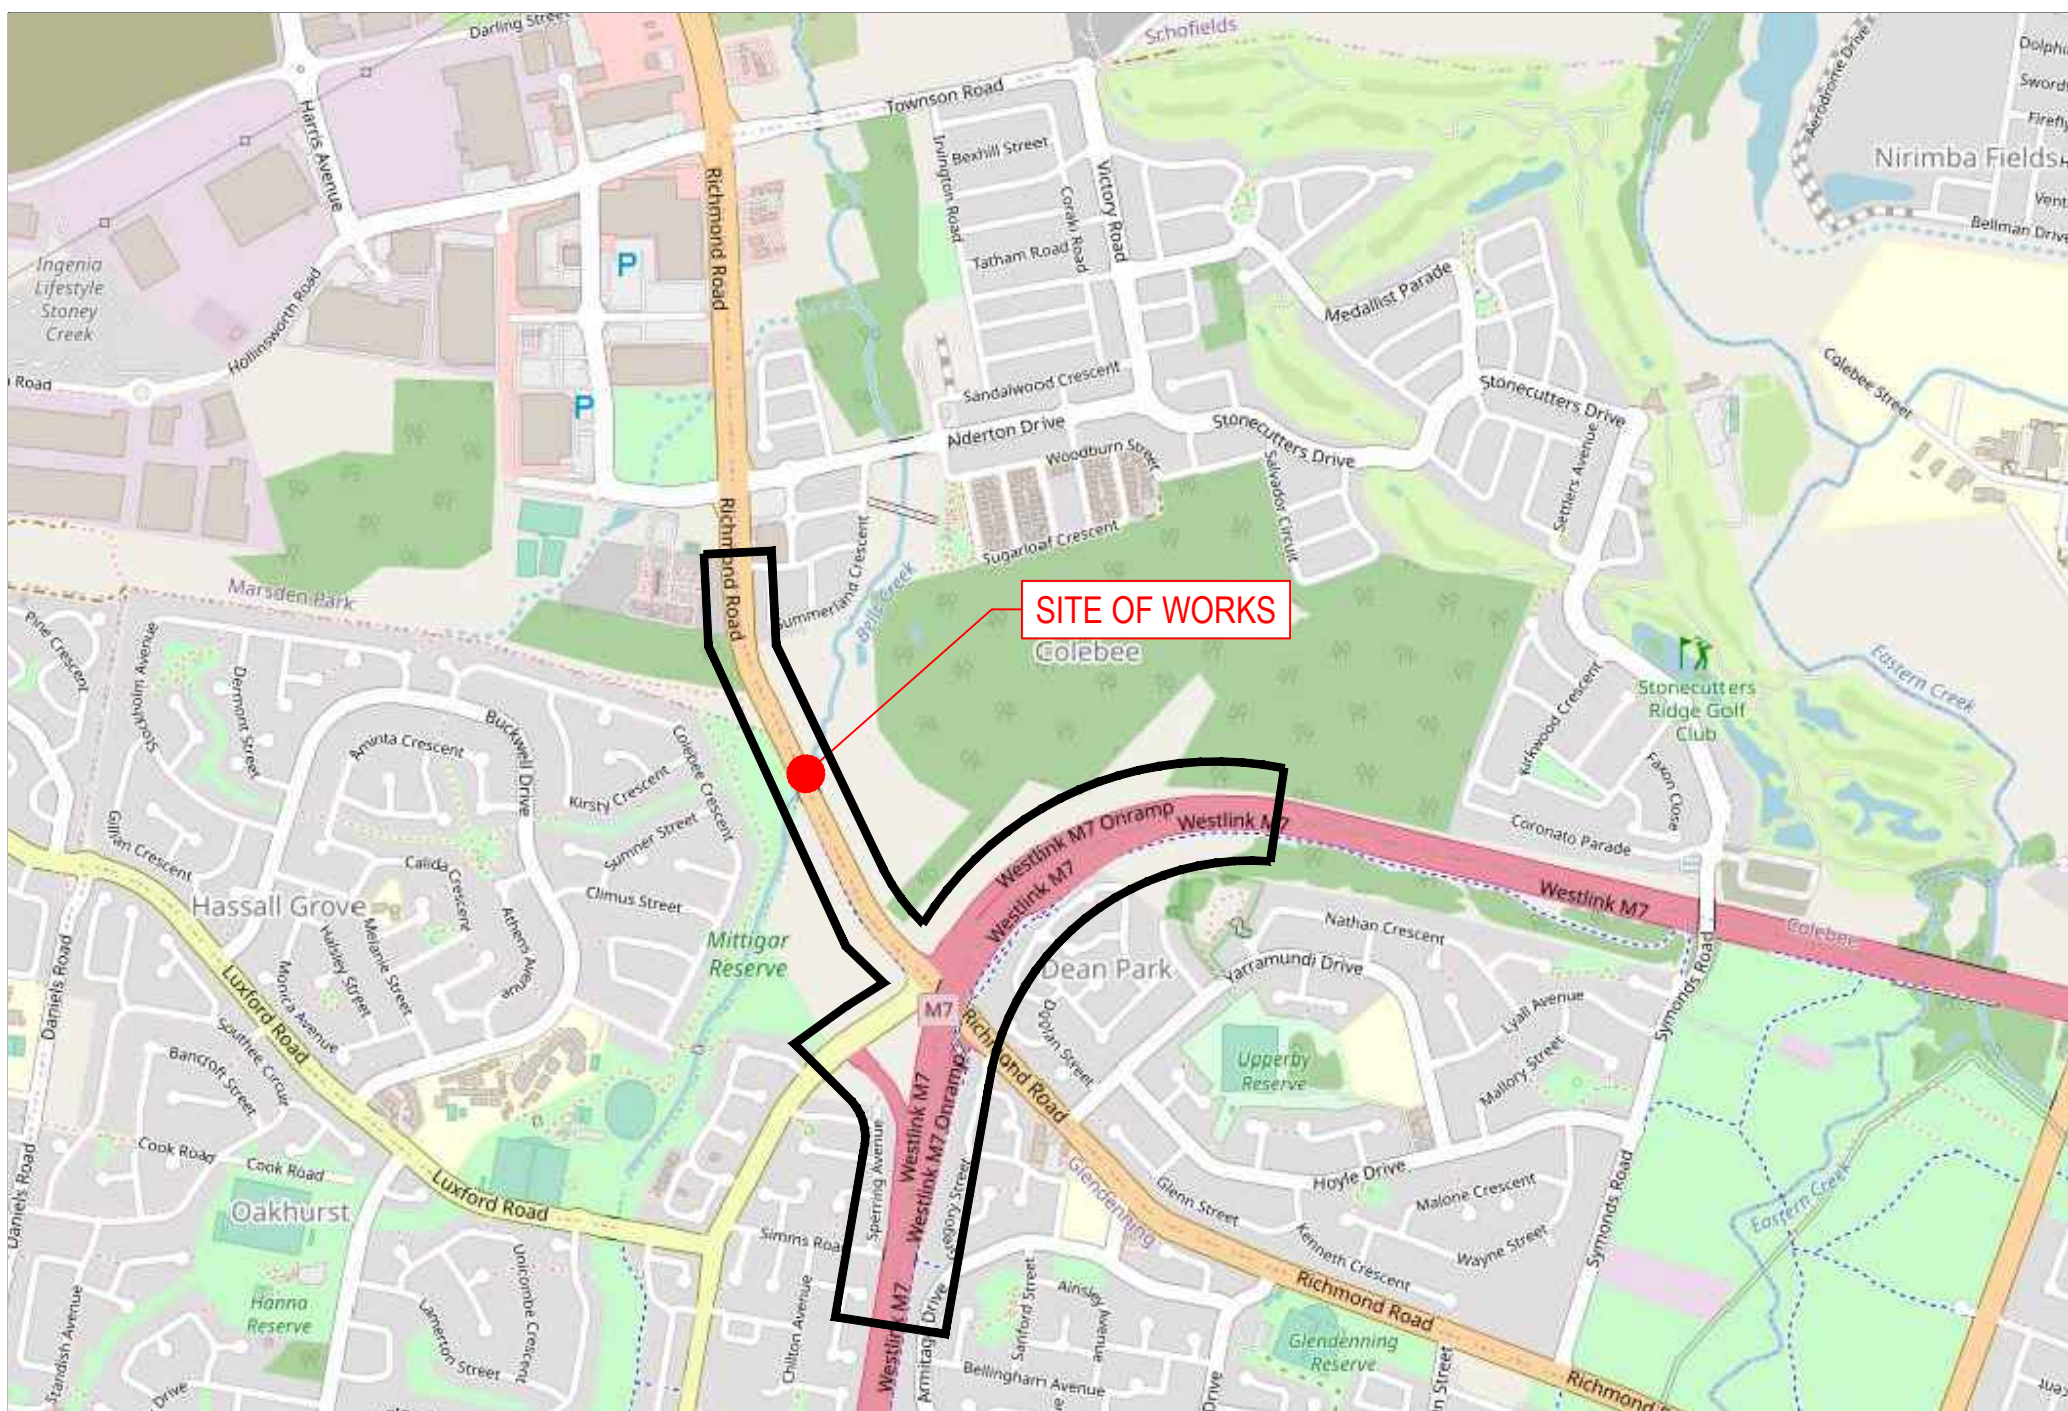

LOCALITY PLAN

Imagery Openmap

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REFERENCES:	THIS DRAWING MAY BE PREPARED IN COLOUR AND MAY BE INCOMPLETE IF COPIED.					SCALE: AS SHOWN	CLIENT:	<div><div><div>This drawing and the related information have been prepared by, or at the request of, Transport for NSW for a specific purpose and may not be used for any purpose other than the purpose intended by Transport for NSW.</div><div>Transport for NSW does not provide any warranties and accepts no liability arising out of the use of this drawing or any of the related information for any purpose other than the intended purpose. This drawing is protected by copyright and no part of this drawing may be reproduced in any form without the express written permission of Transport for NSW.</div></div><div><div><div><div><div><div></div><div>NSW</div><div>GOVERNMENT</div></div><div><div>Transport</div><div>for NSW</div></div></div></div></div><div><div><div><div><div></div><div>Stantec</div></div><div>LVL 9, 203 PACIFIC HWY ST. LEONARDS, SYDNEY, NSW TRANSPORT</div></div><div><div>DRAWN _____ A.RODRIGUEZ _____ 07.02.25</div><div>DESIGNED _____ B.BLACKER _____ 07.02.25</div><div>DRG CHECK _____ K.CURLEY _____ 07.02.25</div><div>DESIGN CHECK _____ L.NICHOLS _____ 07.02.25</div><div>PROJ/DES MNGR J.FONG _____ 07.02.25</div><div>APPROVED _____ A.NEWMAN _____ 07.02.25</div></div></div></div></div></div>			
RRM7Y2T-STANA-0537-DE-M3D-000001						PREPARED FOR:					
C	ISSUED FOR 100% SUBMISSION - COMMENT CLOSE OUT			BB/ 07.02.25	DG/ 07.02.25	AN/ 07.02.25					
B	ISSUED FOR 100% SUBMISSION			BB/ 09.12.24	DG/ 09.12.24	AN/ 09.12.24					
A	ISSUED FOR 80% SUBMISSION			RC/ 05.08.24	DG/ 05.08.24	JF/ 05.08.24					
REV	DESCRIPTION			DESIGNER INITIAL/DATE	VERIFIED INITIAL/DATE	APPROVED INITIAL/DATE					
COORDINATE SYSTEM: MGA2020 ZONE 56				GDA2020		HEIGHT DATUM: AHD	DESIGN LOT CODE:				


BLACKTOWN CITY COUNCIL			
MR537 RICHMOND ROAD - M7			
RICHMOND ROAD WIDENING, BETWEEN M7 & TOWNSON RD			
GENERAL			
COVER SHEET			
DRAWING SET No: DS2024/000705		PART:	SHEET: OF
STATUS: 100% CONCEPT DESIGN		BRIDGE No: ©	
DRG No.	REV	VER	EDMS No. AMD No.
RRM7Y2T-STANA-0537-GN-DRG-000001			

FILE NAME: RRM7Y2T-STANA-0537-GN-DRG-000001.dwg

PLOT DATE & TIME: 07/02/2025 10:49:23 AM

RRM7Y2T-STANA-0537-GN-DRG-000001

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A	DRAWING NO.												TITLE												DRAWING NO.												TITLE																																			
	RRM7Y2T-STANA-0537-SD-DRG-000102												STORMWATER MANAGEMENT PLANS - SHEET 2												RRM7Y2T-STANA-0537-FN-DRG-000510												ROAD FURNITURE, SIGNPOSTING & PAVEMENT MARKING SCHEDULES - SHEET 10 SUPERSEDED																																			
	RRM7Y2T-STANA-0537-SD-DRG-000103												STORMWATER MANAGEMENT PLANS - SHEET 3																																																											
	RRM7Y2T-STANA-0537-SD-DRG-000104												STORMWATER MANAGEMENT PLANS - SHEET 4												ROAD LIGHTING																																															
	RRM7Y2T-STANA-0537-SD-DRG-000105												STORMWATER MANAGEMENT PLANS - SHEET 5												RRM7Y2T-STANA-0537-LV-DRG-000101												ROAD LIGHTING PLANS - SHEET 1																																			
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	INFORMATION TECHNOLOGY NETWORKS SYSTEMS																								RRM7Y2T-STANA-0537-TT-DRG-000011												ITS CONDUIT ARRANGEMENTS CABLE CROSS SECTION																																			
	RRM7Y2T-STANA-0537-TT-DRG-000021												ITS CCTV ARRANGEMENTS TRAFFIC SIGNAL POST AND CAMERA POLE ELEVATIONS																																																											
	RRM7Y2T-STANA-0537-TT-DRG-000031												ITS OFF RAMP QUEUE DETECTION CONCEPT DESIGN																																																											
G	RRM7Y2T-STANA-0537-TT-DRG-000041												ITS FIELD CABINET DIMENSIONS AND LAYOUT CABINET PLANS																																																											
DRAWING COLOUR CODED - PRINT ALL COPIES IN COLOUR																								OFFICIAL: SENSITIVE NSW GOVERNMENT																								NOT FOR CONSTRUCTION																								
H	REFERENCES:												THIS DRAWING MAY BE PREPARED IN COLOUR AND MAY BE INCOMPLETE IF COPIED.												SCALE: AS SHOWN												CLIENT:												This drawing and the related information have been prepared by, or at the request of, Transport for NSW for a specific purpose and may not be used for any purpose other than the purpose intended by Transport for NSW. Transport for NSW does not provide any warranties and accepts no liability arising out of the use of this drawing or any of the related information for any purpose other than the intended purpose. This drawing is protected by copyright and no part of this drawing may be reproduced in any form without the express written permission of Transport for NSW.												BLACKTOWN CITY COUNCIL MR537 RICHMOND ROAD - M7 RICHMOND ROAD WIDENING, BETWEEN M7 & TOWNSON RD GENERAL DRAWING INDEX SHEET 2											
	RRM7Y2T-STANA-0537-DE-M3D-000001																																																																							
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COORDINATE SYSTEM: MGA2020 ZONE 56																								HEIGHT DATUM: AHD												DESIGN LOT CODE:												DRAWING SET No: DS2024/000705 STATUS: 100% CONCEPT DESIGN DRG No. RRM7Y2T-STANA-0537-GN-DRG-000003																								
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DRAWING NO.

TITLE

RRM7Y2T-STANA-0537-TT-DRG-000042	ITS FIELD CABINET COMMUNICATIONS SINGLE LINE DIAGRAM - SUPERSEDED
RRM7Y2T-STANA-0537-TT-DRG-000043	ITS FIELD CABINET ELECTRICAL SINGLE LINE DIAGRAM
RRM7Y2T-STANA-0537-TT-DRG-000051	ITS POLE MOUNTED CABINET (PMC) COMMUNICATIONS AND ELECTRICAL SINGLE LINE DIAGRAM
RRM7Y2T-STANA-0537-TT-DRG-000061	ITS TOP HAT CABINET / TCS TOP HAT CABINET COMMUNICATIONS AND ELECTRICAL SINGLE LINE DIAGRAM
RRM7Y2T-STANA-0537-TT-DRG-000101	ITS PLAN - SHEET 1
RRM7Y2T-STANA-0537-TT-DRG-000102	ITS PLAN - SHEET 2
RRM7Y2T-STANA-0537-TT-DRG-000103	ITS PLAN - SHEET 3
RRM7Y2T-STANA-0537-TT-DRG-000104	ITS PLAN - SHEET 4
RRM7Y2T-STANA-0537-TT-DRG-000105	ITS PLAN - SHEET 5
RRM7Y2T-STANA-0537-TT-DRG-000106	ITS PLAN - SHEET 6
BY OTHERS	
BR	BRIDGES
LA	LANDSCAPING
SE	TRAFFIC CONTROL SIGNALS

NOTE:
1. DRAWING NUMBERS AND DESCRIPTIONS IN GREY REPRESENT THE NORTHERN SECTION OF RICHMOND ROAD DESIGN. REFER TO RICHMOND ROAD DETAILED DESIGN, DRAWING SET NUMBER DS/2024/001241 FOR DETAILS.

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REFERENCES:

RRM7Y2T-STANA-0537-DE-M3D-000001

QR CODE:
(OPTIONAL ONLY ON APPROVED DRAWINGS)

B	ISSUED FOR 100% SUBMISSION - COMMENT CLOSE OUT	BB/ 07.02.25	DG/ 07.02.25	AN/ 07.02.25	
A	ISSUED FOR 100% SUBMISSION	BB/ 09.12.24	DG/ 09.12.24	AN/ 09.12.24	
REV	DESCRIPTION	DESIGNER INITIAL/DATE	VERIFIED INITIAL/DATE	APPROVED INITIAL/DATE	
COORDINATE SYSTEM: MGA2020 ZONE 56		HEIGHT DATUM: AHD		DESIGN LOT CODE:	

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SCALE: AS SHOWN

CLIENT:

NSW GOVERNMENT

Transport for NSW

PREPARED FOR:

LVL 9, 203 PACIFIC HWY
ST. LEONARDS, SYDNEY, NSW
TRANSPORT

Stantec

DRAWN _____ A.RODRIGUEZ _____ 07.02.25
DESIGNED _____ B.BLACKER _____ 07.02.25
DRG CHECK _____ K.CURLEY _____ 07.02.25
DESIGN CHECK _ L.NICHOLS _____ 07.02.25
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APPROVED _____ A.NEWMAN _____ 07.02.25

BLACKTOWN CITY COUNCIL
MR537 RICHMOND ROAD - M7
RICHMOND ROAD WIDENING, BETWEEN M7 & TOWNSON RD
GENERAL
DRAWING INDEX
SHEET 3

DRAWING SET No: DS2024/000705

PART: SHEET: 3 OF 3 A1

STATUS: 100% CONCEPT DESIGN

BRIDGE No: ©

DRG No: RRM7Y2T-STANA-0537-GN-DRG-000004

REV B

VER .

EDMS No.

AMD No.

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


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A	<div>GENERAL</div> <div>1. DRAWINGS TO BE READ IN CONJUNCTION WITH ALL OTHER SPECIFICATIONS FOR THE PROJECT.</div> <div>2. LEVELS ARE TO AUSTRALIAN HEIGHT DATUM (AHD).</div> <div>3. CO-ORDINATES ARE TO MAP GRID AUSTRALIA GDA 2020/MGA (ZONE 56).</div> <div>4. ALL DIMENSIONS ARE IN METRES U.N.O. ALL LEVELS, METREAGES, STATIONS AND CO-ORDINATES ARE EXPRESSED IN METRES.</div> <div>5. SERVICES ARE SHOWN INDICATIVE ONLY. CONTRACTORS TO CONFIRM LOCATION OF ALL SERVICES PRIOR TO COMMENCING WORK. CONTRACTOR TO ENSURE ADOPTED METHOD OF CONSTRUCTION WILL AVOID DAMAGE TO ALL SERVICES.</div> <div>6. ALL WORK TO BE UNDERTAKEN IN ACCORDANCE WITH THE LATEST VERSION OF TNSW SPECIFICATIONS AT THE TIME OF TENDER UNLESS NOTED OTHERWISE.</div> <div>7. CONCEPT DRAWING ARE NOT FOR CONSTRUCTION PURPOSES.</div>												A
B	<div>SAFETY IN DESIGN INFORMATION</div> <div>1. THESE DRAWINGS ARE TO READ IN CONJUNCTION WITH TNSW SPECIFICATION G22. THIS DOCUMENT LISTS SOME DESIGN RELATED WORK HEALTH AND SAFETY HAZARDS ASSOCIATED WITH THE PROJECT DESIGN, CONSTRUCTION AND OPERATION. THERE MAY BE OTHER HAZARDS ASSOCIATED WITH THE PROJECT DESIGN, CONSTRUCTION AND OPERATION NOT STATED IN THIS DOCUMENT. THIS DOCUMENT DOES NOT RELIEVE THE CONTRACTOR OF ITS SAFETY OBLIGATIONS UNDER THE CONTRACT AND RELEVANT LEGISLATION.</div>												B
C	<div>TNSW MODEL DRAWINGS</div> <div>1. TNSW MODEL DRAWINGS CAN BE FOUND AT THE FOLLOWING LOCATION: https://roads-waterways.transport.nsw.gov.au/business-industry/partners-suppliers/documents/standard-drawings/list_of_standard_road_drawings.pdf.</div>												C
D	<div>FOUNDATION TREATMENT FOR EMBANKMENTS AND CUTTING SCHEDULE</div> <div>1. FOR GROUNDWATER LEVELS OBSERVED DURING AND POST GEOTECHNICAL INVESTIGATION WORKS, REFER TO THE GEOTECHNICAL INTERPRETIVE REPORT FOR THE PROJECT (REPORT NO. RRM7Y2T-STANA-NWW-GE-RPT-00003).</div> <div>2. ALL FOUNDATION TREATMENTS SHALL BE CONSTRUCTED IN ACCORDANCE WITH TNSW TS02158.1 (R44).</div> <div>3. THE FOUNDATION TREATMENTS AS LISTED GEOTECHNICAL DESIGN REPORT (REPORT NO. RRM7Y2T-STANA-NWW-GE-RPT-00004) ARE INDICATIVE ONLY. ANTICIPATED FOUNDATION TREATMENTS ARE SUBJECT TO FIELD VERIFICATION BY THE SITE GEOTECHNICAL ENGINEER. BASED ON CONDITIONS ON-SITE, FOUNDATION TREATMENTS WILL BE RE-ASSESSED IN ACCORDANCE WITH TNSW TS02158.1 (R44).</div> <div>4. WHERE THE EXISTING EMBANKMENT IS TO BE RETAINED AND THE NEW CARRIAGEWAY IS BEING CONSTRUCTED PARTIALLY OVER THE EXISTING EMBANKMENT, THE NEW EMBANKMENT SHALL BE TERRACED INTO THE EXISTING EMBANKMENT IN ACCORDANCE WITH TNSW TS02158.1 (R44).</div> <div>5. FOUNDATION TREATMENT MAY VARY ACROSS THE FOUNDATION.</div> <div>6. FOUNDATION TREATMENTS FOR TIE INS TO LOCAL ROADS AND PROPERTY ACCESS TO BE AS PER THAT SPECIFIED FOR THE ADJACENT MAIN ALIGNMENT.</div> <div>7. MIXING AND MODIFYING TO A DEPTH OF 300mm USING 3% W/W HYDRATED LIME AS PER TFNSW TS02158.1 (R44) SHALL BE CARRIED OUT TO CREATE WORKING PLATFORM FOR THE OVERLAYING UPPER ZONE FORMATION (UZF) AND PAVEMENT LAYERS.</div>												D
E	<div>ENVIRONMENTAL CONSIDERATIONS</div> <div>1. REFER TO QA SPECIFICATIONS G36 AND G38 FOR ENVIRONMENTAL CONSIDERATIONS.</div> <div>2. THE CONTRACTOR WILL BE RESPONSIBLE FOR THE DESIGN, IMPLEMENTATION AND MAINTENANCE OF ALL EROSION AND SEDIMENT CONTROLS REQUIRED DURING THE WORKS.</div> <div>3. TEMPORARY SEDIMENTATION BASINS, IF REQUIRED, WILL BE CONSTRUCTED ABOVE EXISTING GROUND WITHOUT LOWERING THE EXISTING GROUND LEVEL.</div>												E
F													F
G													G
H	<div>DRAWING COLOUR CODED - PRINT ALL COPIES IN COLOUR</div> <div>REFERENCES: RRM7Y2T-STANA-0537-DE-M3D-000001</div> <div>THIS DRAWING MAY BE PREPARED IN COLOUR AND MAY BE INCOMPLETE IF COPIED.</div> <div>SCALE: AS SHOWN</div> <div>CLIENT:  </div> <div>PREPARED FOR:</div> <div><div><div><div>This drawing and the related information have been prepared by, or at the request of, Transport for NSW for a specific purpose and may not be used for any purpose other than the purpose intended by Transport for NSW.</div><div>Transport for NSW does not provide any warranties and accepts no liability arising out of the use of this drawing or any of the related information for any purpose other than the intended purpose. This drawing is protected by copyright and no part of this drawing may be reproduced in any form without the express written permission of Transport for NSW.</div></div><div><div>LVL 9, 203 PACIFIC HWY ST. LEONARDS, SYDNEY, NSW TRANSPORT</div></div><div>DRAWN _____ A.RODRIGUEZ _____ 07.02.25 DESIGNED _____ B.BLACKER _____ 07.02.25 DRG CHECK _____ K.CURLEY _____ 07.02.25 DESIGN CHECK _ L.NICHOLS _____ 07.02.25 PROJ/DES MNGR J.FONG _____ 07.02.25 APPROVED ____ A.NEWMAN _____ 07.02.25</div></div><div>BLACKTOWN CITY COUNCIL MR537 RICHMOND ROAD - M7 RICHMOND ROAD WIDENING, BETWEEN M7 & TOWNSON RD GENERAL NOTES SHEET 1</div><div><div>DRAWING SET No: DS2024/000705</div><div>PART:</div><div>SHEET: 1 OF 2</div><div>A1</div></div><div><div>STATUS: 100% CONCEPT DESIGN</div><div>BRIDGE No:</div><div>©</div></div><div><div>DRG No. RRM7Y2T-STANA-0537-GN-DRG-000021</div><div>REV C</div><div>VER .</div><div>EDMS No.</div><div>AMD No.</div></div></div>												H
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UTILITIES



UTILITY INFORMATION SHOWN TO THE PLANS DOES NOT DEPICT ANY MORE THAN THE PRESENCE OF A SERVICE BASED ON AVAILABLE DOCUMENTARY EVIDENCE. THE PRESENCE OF A UTILITY SERVICE, IT'S SIZE AND LOCATION SHOULD BE CONFIRMED BY FIELD INSPECTION PRIOR TO THE COMMENCEMENT OF ROAD WORKS, AND THE RELATIVE UTILITY PLANS OBTAINED THROUGH BEFORE YOU DIG AUSTRALIA (www.byda.com.au). CAUTION SHOULD BE EXERCISED WHEN WORKING IN THE VICINITY OF ALL UTILITY SERVICES.





- 1. THE UTILITIES DRAWINGS AND THE NOTES BELOW ARE FOR COORDINATION PURPOSES ONLY.
- 2. THE UTILITY AUTHORITIES RELEVANT TO THIS DESIGN PACKAGE ARE:

UTILITIES

- 3. THE UTILITY AUTHORITIES MUST BE CONSULTED REGARDING THE COORDINATION AND CONSTRUCTION OF THE UTILITY AND ROADWORKS.
- 4. THE LOCATIONS OF UTILITIES SHOWN HAVE BEEN PRODUCED FROM BEFORE YOU DIG AUSTRALIA DATA AND LIMITED SURVEY
- 5. ALL UTILITY LOCATIONS, ALIGNMENTS AND DEPTHS ARE TO BE CONFIRMED BY THE CONTRACTOR PRIOR TO COMMENCING ANY WORK WHICH MAY IMPACT THE UTILITY.
- 6. THE UTILITY DRAWINGS SHALL BE READ IN CONJUNCTION WITH ALL OTHER ENGINEERING DRAWINGS AND SPECIFICATIONS AND WITH RELEVANT UTILITY AUTHORITY'S CERTIFIED AND / OR APPROVED DETAILED DESIGN DRAWINGS AND SPECIFICATIONS.
- 7. LOCATION AND LEVEL OF ALL SERVICES CROSSING PROPOSED DRAINAGE MUST BE OBTAINED BY CONTRACTOR PRIOR TO CONSTRUCTION. ALL LEVELS MUST BE CHECKED FOR CONFLICT WITH ANY SERVICES, AND ANY CONFLICTS TO BE RESOLVED WITH THE ENGINEERING MANAGER.
- 8. ALL CHANGES TO THE UTILITY DESIGN MUST BE APPROVED AND AUTHORISED BY THE RELEVANT UTILITY AUTHORITY AND THE PRINCIPAL PRIOR TO COMMENCING WORK.
- 9. UNCHARTED UTILITY SERVICES MAY BE PRESENT ON THE SITE. THE CONTRACTOR MUST MAKE ALL EFFORTS TO IDENTIFY THE PRESENCE OF UTILITY SERVICES ON THE SITE AND ARRANGE FOR RELOCATION OR PROTECTION AS NECESSARY TO SUIT THE PARTICULAR WORKS, AS AGREED WITH THE PRINCIPAL AND IN CONJUNCTION WITH THE RELEVANT UTILITY AUTHORITY.
- 10. PRIOR TO ANY EXCAVATION, EXISTING GROUND CONDITIONS MUST BE ASSESSED ON SITE BY AN EXPERIENCED ENGINEERING GEOLOGISTS OR GEOTECHNICAL ENGINEER BASED ON SITE INVESTIGATION RESULTS. THIS INCLUDES FOR THE INSTALLATION OF UTILITIES AND POLES, AND FOR EXCAVATIONS NEAR CUT OR FILL BATTERS.
- 11. ALL EXCAVATIONS MUST BE CARRIED OUT FOLLOWING THE REGULATIONS SET OUT BY EACH INDIVIDUAL UTILITY SERVICE AUTHORITY. IT IS THE CONTRACTOR'S RESPONSIBILITY TO OBTAIN THESE REGULATIONS AND COMPLY WITH THEM.
- 12. THE CONTRACTOR MUST MAKE ITSELF AWARE OF AND COMPLY WITH ALL UTILITY SERVICE AUTHORITY REGULATIONS AND STANDARDS IN RELATION TO THE USE OF MACHINERY AND EQUIPMENT IN THE VICINITY OF THE UTILITY SERVICES AND WITHIN ANY EASEMENTS.
- 13. VERIFY SETTING OUT INFORMATION WITH UTILITY AUTHORITY BEFORE CONSTRUCTION AND FABRICATION IS COMMENCED.
- 14. THE CONTRACTOR TO CLEARLY MARK THE LOCATION ON THE GROUND OF ADJUSTED UTILITY.
- 15. THE CONTRACTOR MUST CHECK THAT ANY CLEARANCES UTILITY SERVICES SPECIFIED ON THE CERTIFIED UTILITY RELOCATION DRAWINGS ARE ACHIEVED ON SITE.
- 16. PRIOR TO THE COMMISSIONING OF ADJUSTED SERVICES INTEGRITY OF SERVICE & SLEEVING TO BE VERIFIED.
- 17. DO NOT OBTAIN DIMENSIONS BY SCALING FROM THE DRAWING.

UTILITIES

- 18. UTILITY SURVEYS HAVE BEEN LABELLED IN ACCORDANCE WITH AS5488:2022. REFER EXPLANATION BELOW

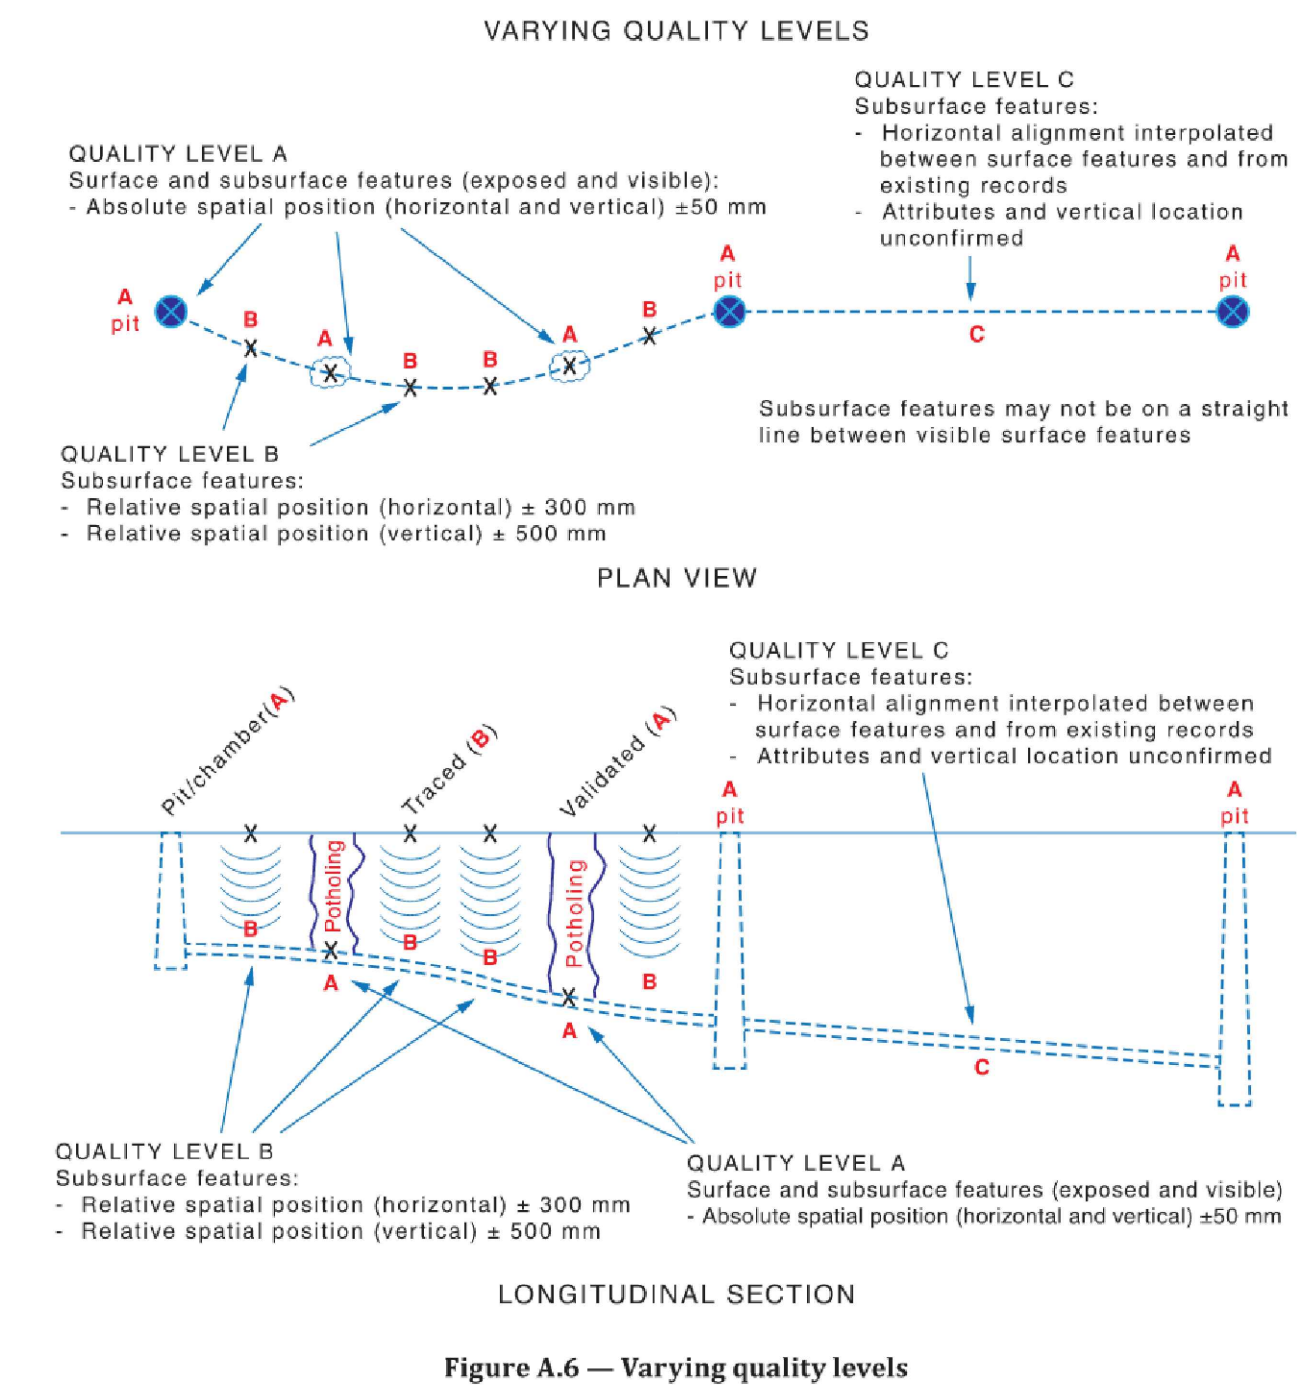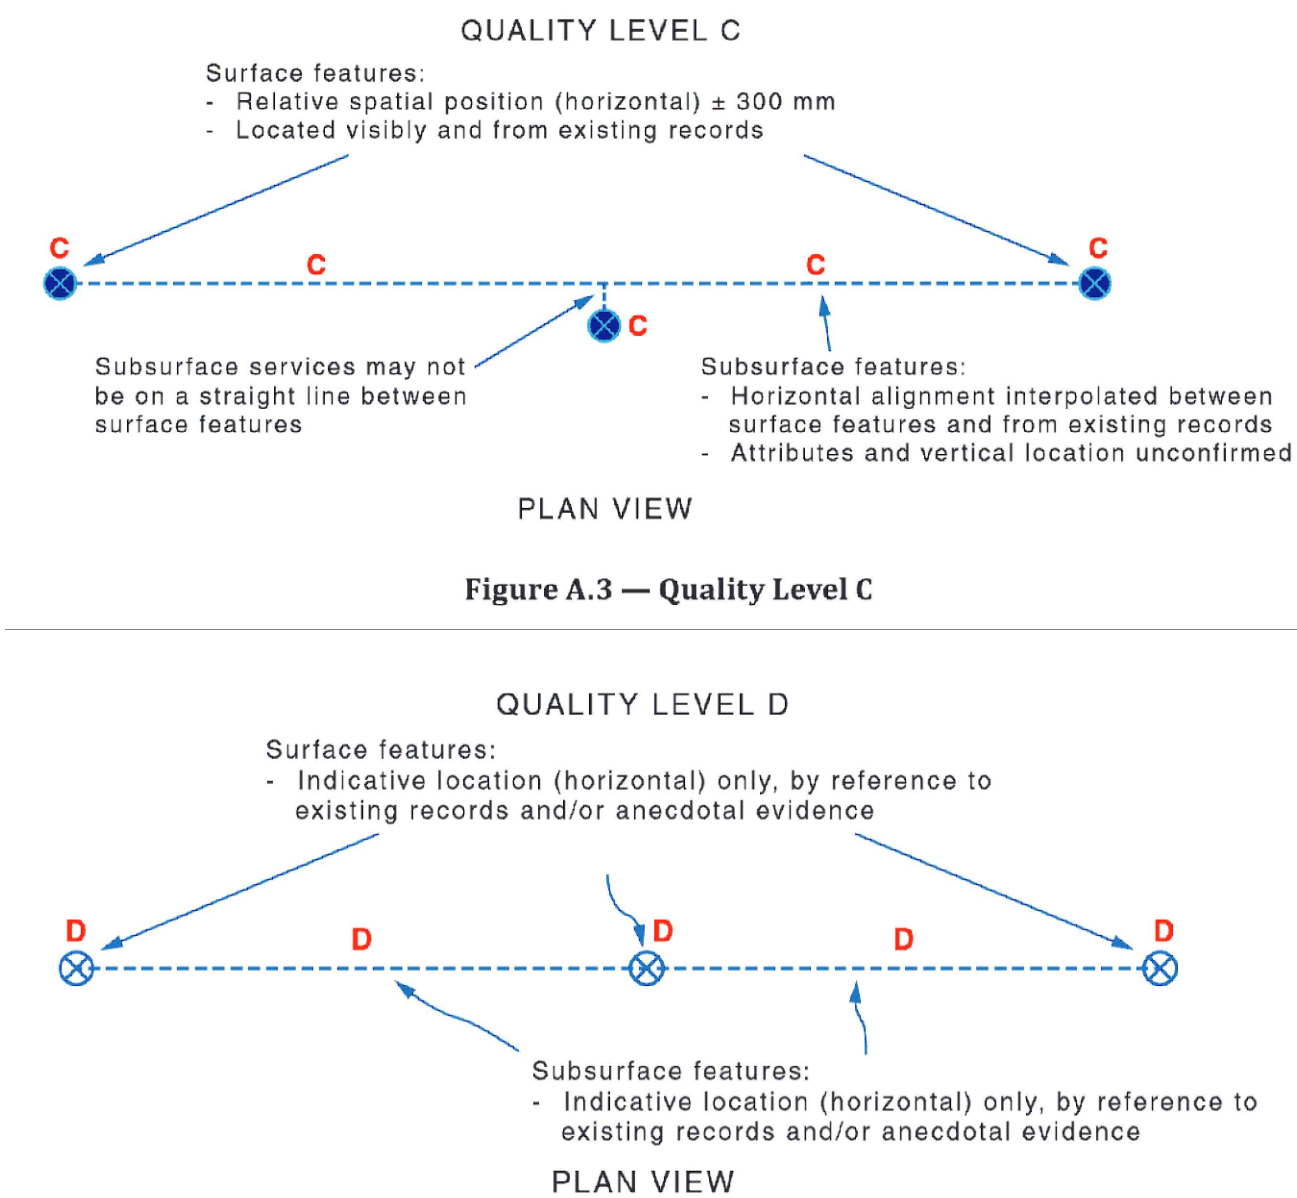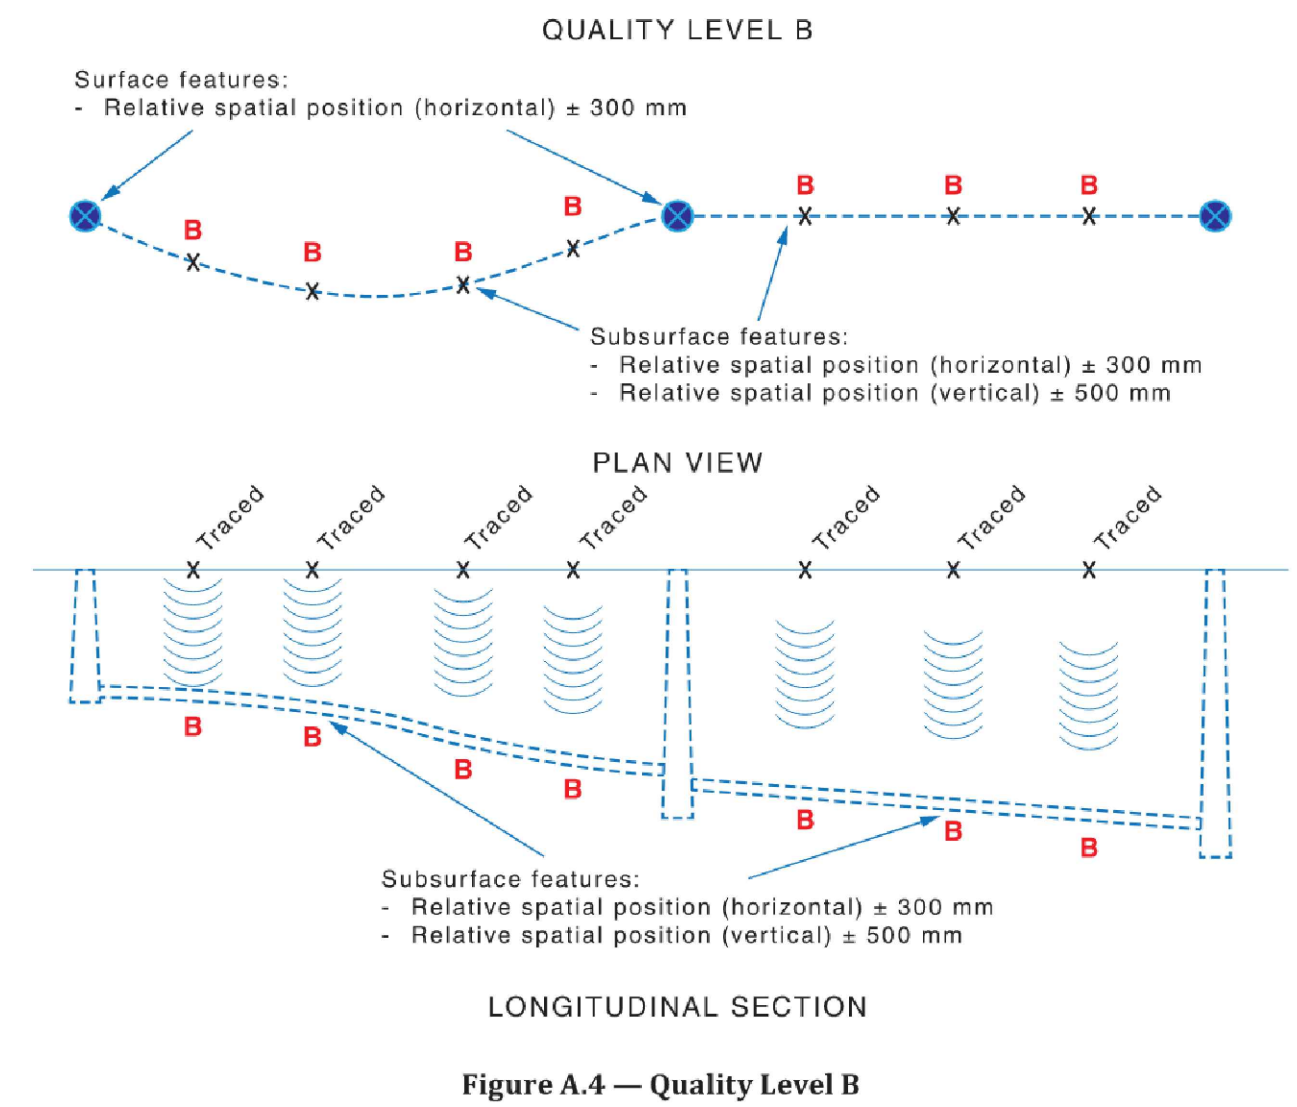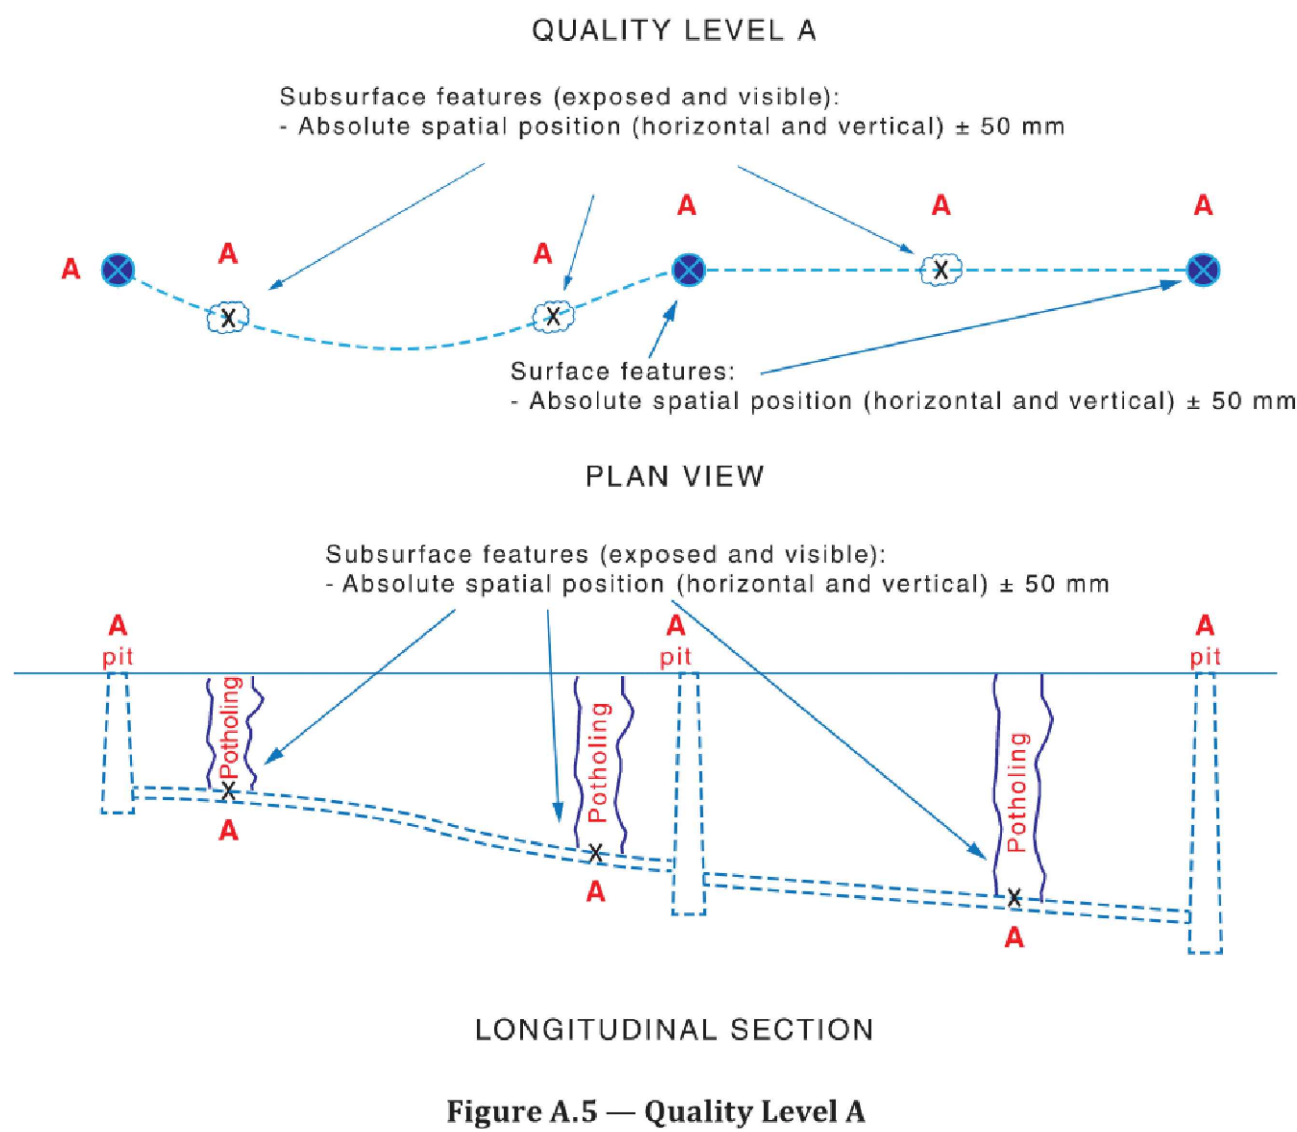

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NOT FOR CONSTRUCTION

REFERENCES:		THIS DRAWING MAY BE PREPARED IN COLOUR AND MAY BE INCOMPLETE IF COPIED.					SCALE: AS SHOWN			CLIENT:		<div>This drawing and the related information have been prepared by, or at the request of, Transport for NSW for a specific purpose and may not be used for any purpose other than the purpose intended by Transport for NSW. Transport for NSW does not provide any warranties and accepts no liability arising out of the use of this drawing or any of the related information for any purpose other than the intended purpose. This drawing is protected by copyright and no part of this drawing may be reproduced in any form without the express written permission of Transport for NSW.</div> <div><div><div><div></div><div>NSW</div><div>GOVERNMENT</div></div><div><div>Transport</div><div>for NSW</div></div></div><div><div><div></div><div>Stantec</div></div><div>LVL 9, 203 PACIFIC HWY ST. LEONARDS, SYDNEY, NSW TRANSPORT</div></div></div>				
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